

WASTEWATER A STA 10+00


SCALE: 1"=5"

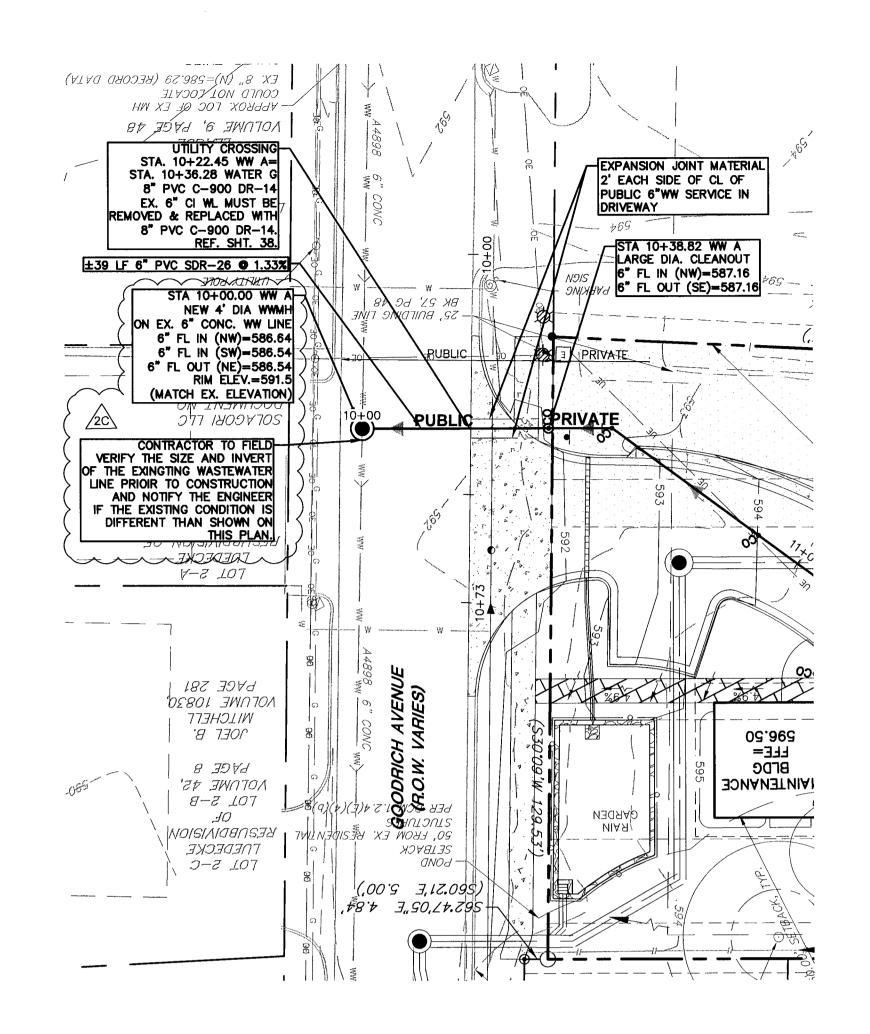

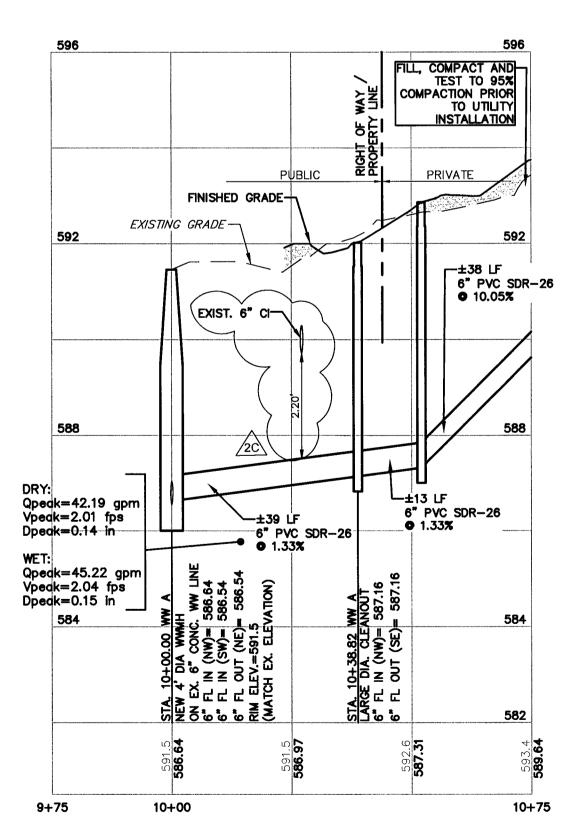


WASTEWATER LINE A

HORIZ: 1"=20' VERT: 1"=2'

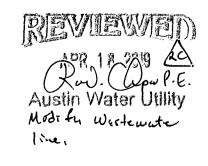

CONTRACTOR TO VERIFY SIZE, LOCATION AND ELEVATION OF ALL EXISTING UTILTIES, AT TIE-IN AND CROSSING LOCATIONS, PRIOR TO START OF CONSTRUCTION

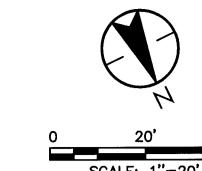


SCALE: 1"=20' LEGEND

LEGEND				
EXISTING	PROPOSED	DESCRIPTION		
(xxx) ‡		PROPERTY LINE / (R.O.W.) LINE RECORD INFORMATION LIGHT POLE		
Ž		POWER POLE		
`e-		DOWN GUY		
	T	TRANSFORMER (SIZE VARIES)		
	G	GENERATOR (SIZE VARIES)		
\oplus	�	FIRE HYDRANT		
Ø	•	WATER VALVE		
		WATER METER		
^		WATER METER VAULT (SIZE VARIES)		
<u>A</u> E		CABLE TV RISER ELECTRIC BOX		
EM.		ELECTRIC METER		
0		GAS METER GAS VALVE		
© =		GRATE INLET		
		CURB INLET (SIZE VARIES)		
55		STORMSEWER LINE		
—— w ——		WATER LINE		
ww		FIRE LINE WASTEWATER LINE		
	G	IGAS LINE		
UE	UE	UNDERGROUND ELECTRIC LINE		
OE	OE	OVERHEAD ELECTRIC		
<i>UT</i>	UT	UNDERGROUND TELEPHONE UNDERGROUND CABLE AND INTERNET		
	UC	TELECOMMUNICATIONS LINE		
EMH O	O	ELECTRIC MANHOLE (SIZE VARIES)		
WWMH O	•	WASTEWATER MANHOLE (SIZE VARIES		
SSMH ()		STORMSEWER MANHOLE (SIZE VARIES		
co°	CO•	WASTEWATER CLEANOUT		
	>	WASTEWATER FLOW DIRECTION		
		CURB & GUTTER		
		CONCRETE SIDEWALKS		
678	FFE 678	FINISH FLOOR ELEVATION CONTOUR		
()))1		TREE TO BE SAVED W/ 1/2 CRITICAL ROOT ZONE		
		HERITAGE TREE W/ 1/2 CRITICAL ROOT ZONE		

WATER & WASTEWATER NOTES

- 1. WATER LINE A: WATER LINE SHALL BE DUCTILE IRON PIPE COMPLYING WITH AWWA C151. LINES 12" DIAMETER AND SMALLER SHALL BE PRESSURE CLASS 350. LINES GREATER THAN 12" DIAMETER SHALL BE PRESSURE CLASS 250.
- A. MATERIAL MUST COMPLY WITH AWWA C900 PRESSURE CLASS 305 (DR14) AND BE RATED ABOVE DESIGN PRESSURE. ACCEPTABLE SIZES ARE 4", 6", 8" 12" AND 16".
- B. AWWA C900 WATER PIPE SHALL NOTE BE USED IN EASEMENTS ON PRIVATE PROPERTY AND SHALL NOT BE USED FOR WASTEWATER FORCE MAINS OR TO CONVEY ANYTHING BUT POTABLE WATER.
- C. CHANGES IN DIRECTION OF PVC PIPE SHALL ONLY BE BY USE OF FITTINGS OR BY DEFLECTING STRAIGHT PIPE SECTIONS AT JOINTS.
- D. LONGITUDINAL BENDING OF PIPE IS NOT ALLOWED.
- F. DEFLECTION OF STRAIGHT PIPE SECTIONS SHALL NOT EXCEED 1 DEGREE AT EACH JOINT (EVEN IF JOINT RESTRAINT DEVICES ARE INSTALLED), WHICH CORRESPONDS TO THE FOLLOWING OFFSET IN PIPE ALIGNMENT: LENGTH OF PIPE, 20' - OFFSET 4" MAXIMUM. ALLOWABLE RADIUS OF CURVATURE IS 1,146' MINIMUM.
- 3. ALL GATE VALVES FOR FIRE HYDRANT ASSEMBLIES SHALL BE LOCATED IN THE PAVEMENT IN ACCORDANCE WITH CITY OF AUSTIN STANDARD DETAIL 511-AW-02. RESTRAIN THE GATE VALVE TO THE TEE.
- 4. GATE VALVE RISERS SHALL NOT BE PLACED IN CURB/GUTTER BUT SHALL EITHER BE PLACED IN STREET (WHERE FEASIBLE) OR BEHIND CURB.
- 5. AT ALL CROSSINGS WITH UNDERGROUND UTILITIES AND STORM SEWERS, PIPE LENGTHS SHALL BE CENTERED AT CROSSING IN ORDER TO KEEP PIPE JOINTS AS FAR AS POSSIBLE FROM CENTER POINT OF CROSSING.
- 6. CONTRACTOR SHALL TEST WATERLINES TO THE NEAREST CUTOFF VALVE AT ALL CONNECTIONS.
- 7. ALL WASTEWATER SERVICE CONNECTIONS SHALL USE SEWER FITTINGS PER SPL WW-227B & 227D.. 8. ALL GRAVITY WASTEWATER PIPE AND SERVICES SHALL BE GREEN-COLORED ASTM D3034 SDR-26 PVC.
- 9. DETECTABLE TRACER TAPE PER SPL WW-597 SPECIFICATION AND INSTALLATION SHALL BE UTILIZED. 10. PRESSURE TESTING PER CITY OF AUSTIN SPECIFICATIONS.
- 11. ALL WASTEWATER MANHOLES WITHIN 9' OF WATER OR RECLAIMED WATER LINES SHALL BE MADE WATERTIGHT. (COA DETAIL
- 12. NEW PIPE CONNECTIONS TO EXISTING MANHOLES SHALL PROVIDE A MINIMUM OF 12" CLEARANCE BETWEEN THE EXISTING PIPE INSIDE DIAMETER AND THE NEW CORE HOLE INSIDE DIAMETER, MEASURED ON THE INSIDE SURFACE OF THE MANHOLE PER UCM SECTION 2.9.4.D.7, NOTE 3.
- 13. CONTRACTOR SHALL REMOVE ABANDONED INFRASTRUCTURE THAT CONFLICTS WITH PROPOSED PIPELINE AS NEEDED, PER LDC SECTION 2.8. ABANDONMENT REQUIREMENTS. CONTRACTOR TO NOTE THAT SOME EXISTING WATER AND WASTEWATER LINES HAVE BEEN PREVIOUSLY ABANDONED AND POTENTIALLY PAVED OVER. WASTEWATER MANHOLES AND WATERLINE APPURTENANCES HAVE BEEN ABANDONED IN PLACE AND ARE NO LONGER FUNCTIONING IN MULTIPLE LOCATIONS. CONTRACTOR SHALL REMOVE ABANDONED INFRASTRUCTURE THAT CONFLICTS WITH PROPOSED PIPELINE AS NEEDED AND PAY SPECIAL ATTENTION TO VERIFY INFRASTRUCTURE AS ABANDONED OR FUNCTIONING PRIOR TO ANY REMOVAL.
- 14. CONTRACTOR TO POTHOLE PRIOR TO START OF CONSTRUCTION TO VERIFY UTILITY CROSSINGS.
- 15. CONTRACTOR TO CONFIRM LOCATIONS AND ELEVATIONS OF EXISTING UTILITIES PRIOR TO START OF CONSTRUCTION AND CONTACT ENGINEER IF IT DIFFERS FROM AS-BUILT INFORMATION.
- 16. CONTRACTOR TO CONFIRM IF EXISTING STREET LIGHTS ARE TO REMAIN AND THAT EXISTING CONDUITS AND BOXES DO NOT CONFLICT WITH PROPOSED UTILITIES.
- 17. UNDERGROUND MAINS FEEDING NFPA 13 SPRINKLER SYSTEMS MUST BE INSTALLED AND TESTED IN ACCORDANCE WITH NFPA 13, AND THE FIRE CODE, BY A LICENSED SPRINKLER CONTRACTOR WITH A PLUMBING PERMIT. THE ENTIRE MAIN MUST BE HYDROSTATICALLY TESTED AT ONE TIME, UNLESS ISOLATION VALVES ARE PROVIDED BETWEEN TESTED SECTIONS.
- 18. UNDERGROUND MAINS FEEDING PRIVATE HYDRANTS MUST BE INSTALLED AND TESTED IN ACCORDANCE WITH NFPA 24, AND THE FIRE CODE, BY A LICENSED CONTRACTOR WITH A PLUMBING PERMIT. THE ENTIRE MAIN MUST BE HYDROSTATICALLY TESTED AT ONE TIME, UNLESS ISOLATION VALVES ARE PROVIDED BETWEEN TESTED SECTIONS.

WATER MAIN USING FA	ACTORY RESTRAINED JO	INT PIPE AS ÁPPROV	ED IN SPL WW-27F, OF	'S SHALL BE RESTRAINED TO TH R MECHANICAL JOINT RESTRAINT
DEVICES AS APPROVED THE PLAN VIEW AND F	D IN SPL WW -27A. THI PROFILE, CALLOUT FRO	E CALCULATED RESTR M BEGINNING STATION	AINT LENGHT(S) SHALL TO END STATION PER	BE INCLUDED AS CALLOUT NOT UMC SECTION 2.9.2.B.9.

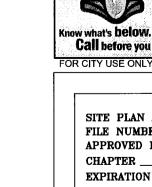

THE LOCATION OF EXISTING UNDERGROUND UTILITIES ARE SHOWN IN AN APPROXIMATE WAY ONLY. THE CONTRACTOR SHALL DETERMINE THE EXACT LOCATION OF ALL EXISTING UTILITIES BEFORE COMMENCING WORK. HE AGREES TO BE FULLY RESPONSIBLE FOR ANY AND ALL DAMAGES WHICH MIGHT BE OCCASIONED BY HIS FAILURE TO EXACTLY LOCATE AND DESCRIPTION AND ALL INDERGROUND LITTLES. AND PRESERVE ANY AND ALL UNDERGROUND UTILITIES.

SITE PLAN APPROVAL SH	
	SOSC.SH APPLICATION DATE: DECEMBER 11, 2017
	ON: N/A UNDER SECTION 118 OF
CHAPTEROF THE	
EXPIRATION DATE (25-5-8	(1,LDC) CASE MANAGER C. DAVIS
PROJECT EXPIRATION DATE	(ORD.#970905-A)DWPZDDZ
Director, Development Services De	partment
RELEASED FOR GENERAL C	OMPLIANCE: AN ZONING: 12-4-CO
Rev. 1	Correction a
Rev. 2	Correction 2
Rev. 3	Correction 3
APPLICABLE. SUBSEQUENT CODE CURRENT AT THE TIM	RDED BY THE PROJECT EXPIRATION DATE, IF SITE PLANS WHICH DO NOT COMPLY WITH THE WE OF FILING, AND ALL REQUIRED BUILDING OF CONSTRUCTION (IF A BUILDING PERMIT IS

NOT REQUIRED), MUST ALSO BE APPROVED PRIOR TO THE PROJECT EXPIRATION DATE.

Permit-Seal JUAN P. MARTINEZ 106158 Project Number: 222010805

Dwn. Chkd. Dsgn. YY.MM.DD Drawing No. DWGNO

Sheet

Revision