300'-0" 100'-0" ALLOWABLE STRUCTURE HEIGHT (FT)\* BUILDING 1 BUILDING 2 OPEN GARAGE BUILD 533.82 AVG. GRADE ENCLOSED GARAGE \*NOTE: ALLOWABLE STRUCTURE HEIGHT MEASURED FROM AVERAGE GRADE PLANE


BLDG HEIGHT DIAGRAM 1

300'-0" 100'-0" STRUCTURE BUILDING 2 BUILDING 3

2 BLDG HEIGHT DIAGRAM 2


SCALE: 1" = 30'-0"

SCALE: 1" = 30'-0"

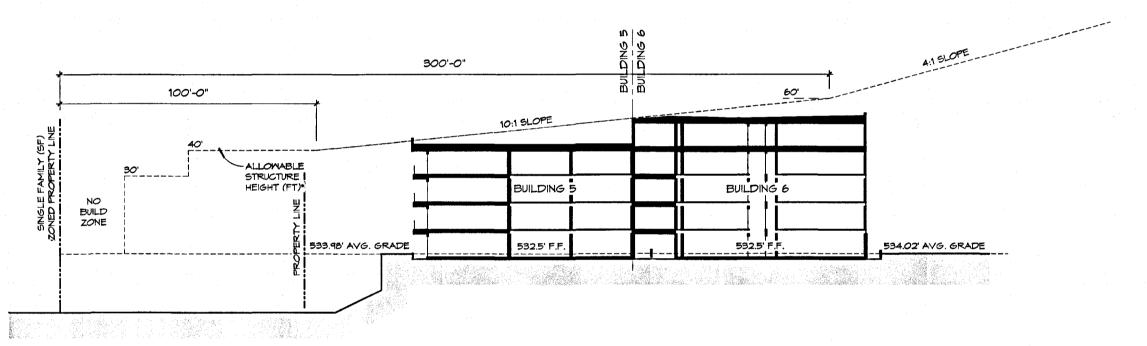


3 BLDG HEIGHT DIAGRAM 3

SCALE: 1" = 30'-0"

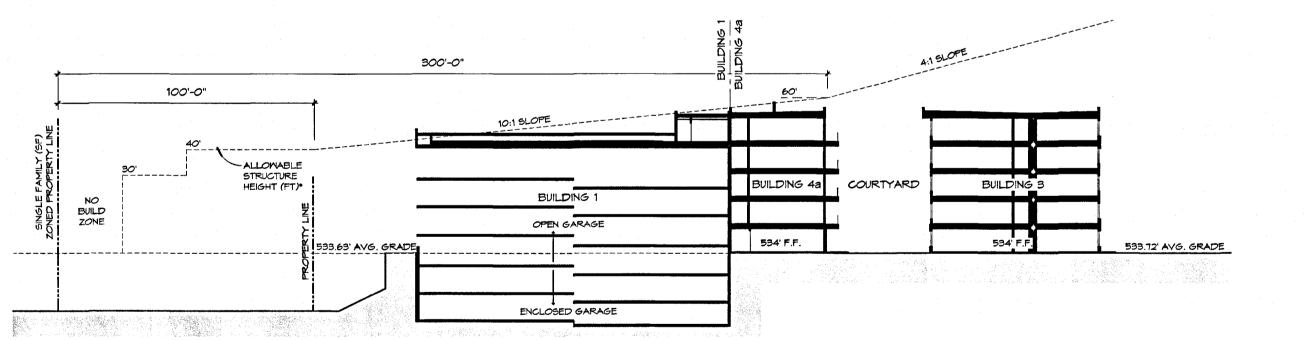

BLDG HEIGHT DIAGRAM 4

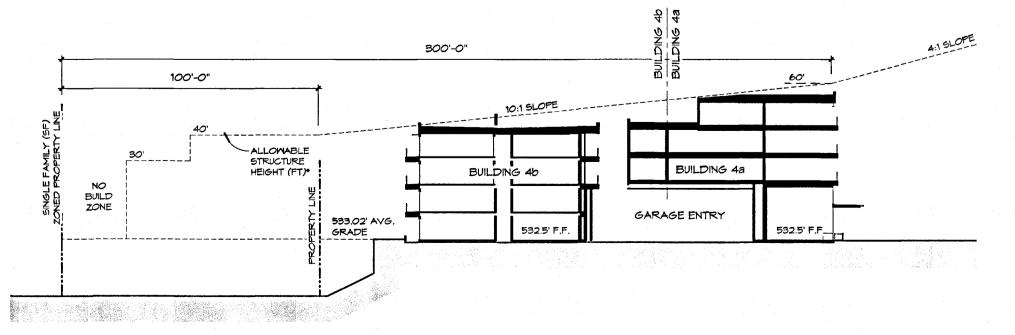

(5) BLDG HEIGHT DIAGRAM 5

Architecture Planning Interiors Research 150 Turtle Creek Blvd; Suite 104D Dallas, Texas 75207 Telephone 214 389 3816 Fax 225 928 4906 E-mail info@lrk.com

## **Fairfield Residential**

7301 North State Highway 161, Suite 260

Irving, Texas 75039

Issues and Revisions

Date Issued / Revised 05.04.18 Schematic Design Set 06,28.18 Completeness Check Set 08.17.18 Design Development Set 11.30.18 85% CD Set 04.19.19 95% CD Set


05.01.19 Site Plan Resubmission

07.30.19 Site Plan Resubmission 3

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conditions at job site.



LRK Project Number: 06.18007.00

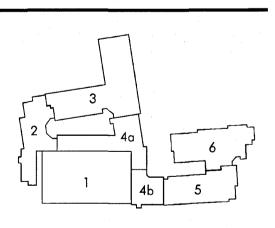1515 South Lamar

1515 South Lamar Blvd.

Drawing Name:

Director, Development Services Department RELEASED FOR GENERAL COMPLIANCE: 12/6/19 ZONING

\_ Correction 2\_ Correction 3—

**BUILDING HEIGHT** DIAGRAM 56 OF 87

Austin, Texas 78704

SITE PLAN APPROVAL Sheet 5 of 82

FILE NUMBER SP-2018-0296C APPLICATION DATE JULY 2, 2018

APPROVED BY COMMISSION ON NA UNDER SECTION UTL OF CHAPTER 15.6 OF THE CITY OF AUSTIN CODE.

EXPIRATION DATE (25-5-81, LDC) 116/11 CASE MANAGER ROSEMARY AVILA

Drawn By: Author Checked By: Checker

Final plat must be recorded by the Project Expiration Date, if applicable. Subsequent Site Plans which do not comply with the Code current at the time of filing, and all required Building Permits and/or a notice of construction (if a building permit is not required), must also be approved prior to the Project Expiration Date.

6 BLDG HEIGHT DIAGRAM KEY

SCALE: 1" = 60'-0"

TITLE 25 - LAND DEVELOPMENT

25-2-531 - HEIGHT LIMIT EXCEPTIONS

(B) Subsection (C) applies to:

(4) for a spire, 30 percent.

AVERAGE GRADE PLANE

and protective covers; and

BUILDING #

2

**4**a

(A) This section provides exceptions to zoning district height limits.

AVERAGE GRADE PLANE

533.63

533.82

533.72

533.02

533.02

534.02

(2) ornamental towers, cupolas, domes, and spires that are not designed for occupancy.

(C) A structure described in Subsection (B) may exceed a zoning district height limit by the greater of:

(2) the amount necessary to comply with a federal or state regulation;(3) for a stack or vent, the amount necessary to comply with generally accepted engineering standards; or

BLDG. FFE

532.50

534.00

534.00

532.50

532.50

532.50

532.50

25-1-21 - DEFINITIONS

(49) HEIGHT, when used in reference to a building, means the vertical distance from the average of the highest and lowest grades adjacent to the building to:

(1) parapet walls, chimneys, vents, and mechanical or safety features including fire towers, stairways, elevator penthouses, heating or cooling equipment, solar installations,

BLDG. HEIGHT AFF

575.23

578.08

588.00

587.25

576.21

578.25

585.85

SINGLE FAMILY LOT LINE

SOUTH LAMAR BOULEVARD

ABOVE AVE. GRADE

PLANE

577.52

578.29

590.21

587.85

576.90

586.31

CONFORMANCE HEIGHT

CLEARANCE (FT)

2.29

0.21

2.21

0.60

0.69

0.46